

OAK VALLEY SCHOOL ROOF REPLACEMENT

BUELLTON UNIFIED SCHOOL DISTRICT

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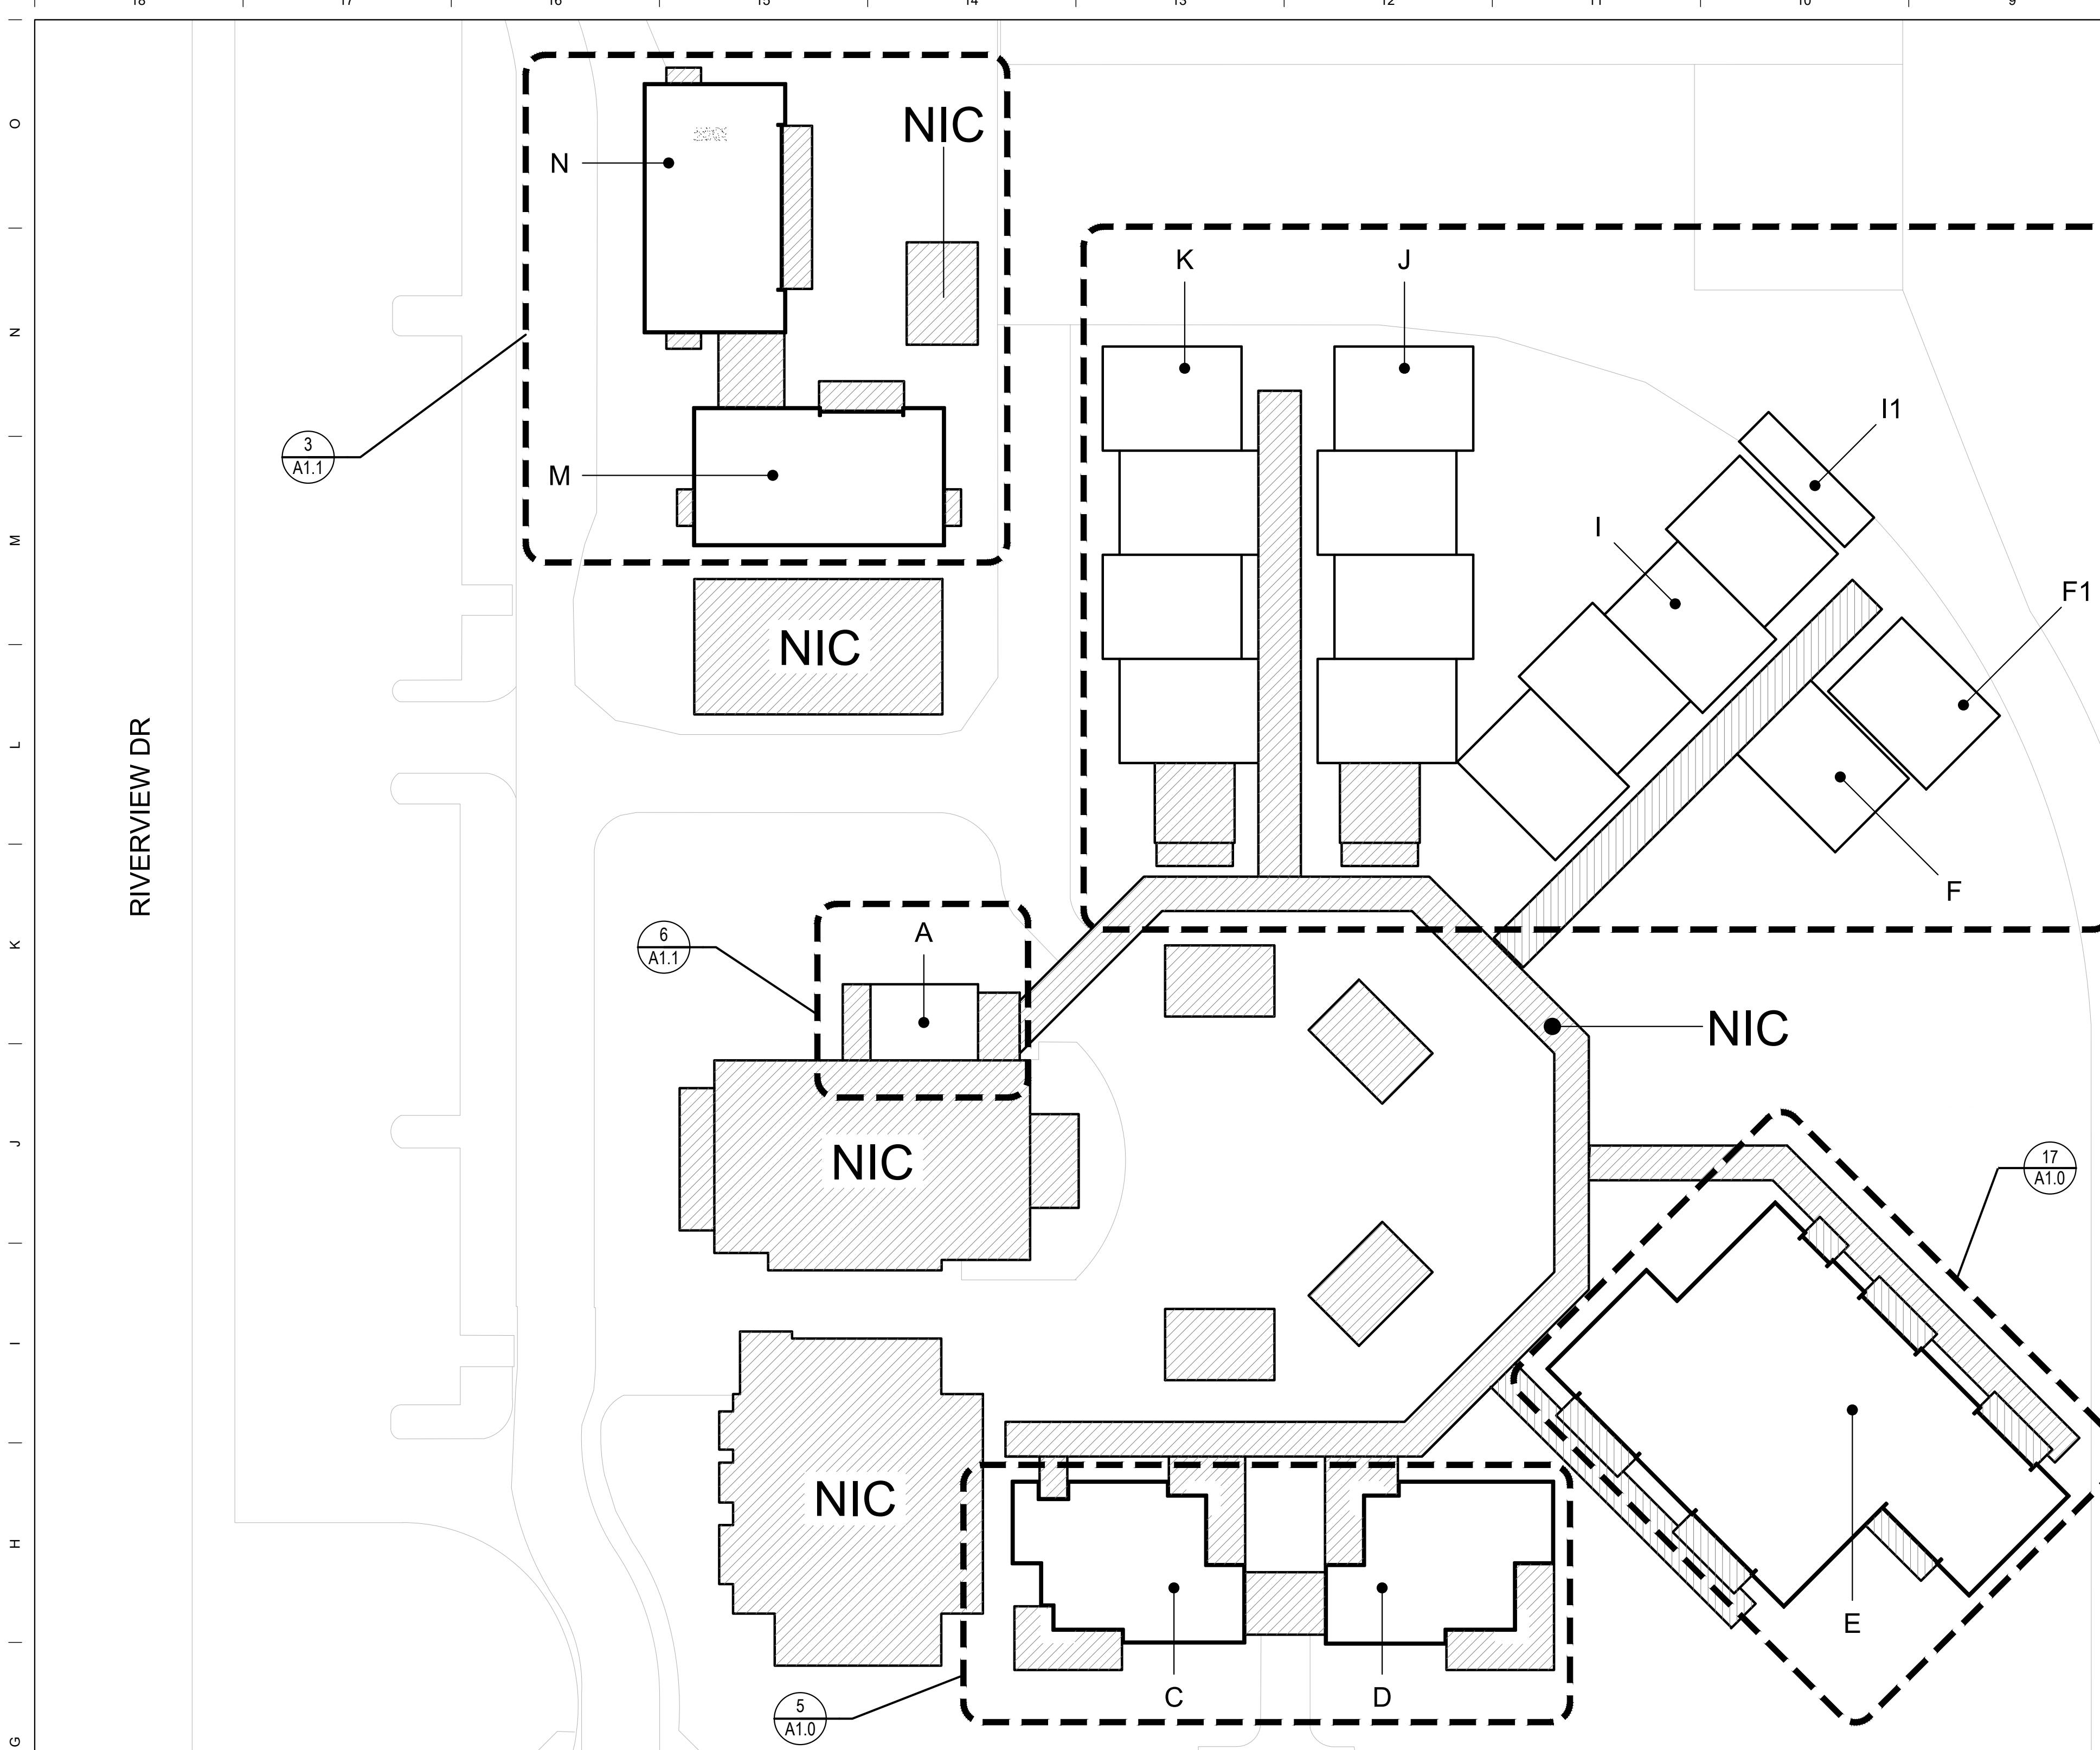
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OAK VALLEY ES

595 2ND ST
BUELLTON, CA 93427

PROJECT: 230610


03/06/2024
95% CD



18 OAK VALLEY SITE MAP
1"=30'-0"

A.D.	AREA DRAIN	EL.	ELEVATION (HEIGHT)	M.O.	MASONRY OPENING	REQ'D	REQUIRED
ADA	AMERICANS WITH DISABILITIES ACT	ELECT.	ELECTRICAL (DRAWING)	MAS.	MASONRY	RES.	RESILIENT
A.F.F.	ABOVE FINISH FLOOR EQUIP	ELEV.	ELEVATION (DRAWING)	MATL.	MATERIAL(S)	REV.	REVISION(S), REVISED
A.F.G.	ABOVE FINISH GRADE	EQUIP	EQUIPMENT	MECH.	MECHANICAL	RPG	RELOCATABLE PAINTED GYP. BOARD
A.H.J.	AUTHORITY HAVING JURISDICTION	EXP	EXPANSION	MEM.	MEMBRANE	RSS.	ROD STOCK AND SEALANT
A/C	AIR CONDITIONING	EXT	EXTERIOR	MEM. WP.	MEMBRANE WATERPROOFING	S.C.	SEALED CONCRETE
ACP.	ACOUSTIC PANEL	F.A.	FULLY ADHERED	MEP	MECHANICAL, ELECTRICAL AND PLUMBING	SCHED	SCHEDULE
ACT.	ACOUSTICAL TILE	F.E.	FIRE EXTINGUISHER	MFR.	MANUFACTURE(R)	SCPL	SOLID CORE PLASTIC LAMINATE
ADJ.	ADJUSTABLE	FB.	FACE BRICK	MH.	MANHOLE	SECT	SECTION
ALT.	ALTERNATE	FD.	FLOOR DRAIN	MIN.	MINIMUM	SHT	SHEET
ALUM.	ALUMINUM	FIN.	FINISH(ED)	MISC.	MISCELLANEOUS	SIM	SIMILAR
ANGL.	ANGLE	FLR.	FLOOR(ING)	MOD	MODULAR	SPC	SPECIAL COATING SYSTEM
B.U.R.	BUILT-UP ROOF	FLSHG.	FLASHING	MTL	METAL	SPEC	SPECIFICATION(S)
BD	BOARD	F.V.	FIELD VERIFY	NIC	NOT IN CONTRACT	SQ.	SQUARE
BLD.	BUILDING	G.B.	GRAB BAR	N.R.	NOT RATED	S.S.	STAINLESS STEEL
BLK.	BLOCK	G.I.	GALVANIZED IRON	N.T.S.	NOT TO SCALE	STD	STANDARD
BM.	BEAM	G.A.	GAUGE	NO.	NUMBER	STL	STEEL
C	CHANNEL	GALV.	GALVANIZED	O.C.	ON CENTER	STRUC	STRUCTURAL
C.J.	CONTROL JOINT	GCMU	GLAZED CONCRETE MASONRY UNIT	O.C.E.W.	ON CENTER EACH WAY	SUSP	SUSPENDED
C.M.U.	CONCRETE MASONRY UNIT	O.D.	OUTSIDE DIAMETER	O.C.I.	OWNER FURNISHED, CONTRACTOR INSTALLED	SYS.	SYSTEM
C.W.	COLD WATER	GEN.	GENERAL	T.O.	TOP OF	T.O.B.	TOP OF WOOD BLOCKING
CFMF	COLD FORMED METAL FRAMING	GL.	GLASS / GLAZING	O.H.	OPPOSITE HAND	T.O.M.	TOP OF MASONRY
CL	CENTERLINE	GR.	GRADE	O.P.	OPPOSITE	T.O.S.	TOP OF STEEL
CLG.	Ceiling	GTP.	GLAZED TILE PAVER	OPNG.	OPENING	TEL	TELEPHONE
CLR.	CLEAR	GYP.	GYP. DRYWALL	OPP.	OPPOSITE	THK	THICKNESS
COL.	COLUMN	H.W.	HOT WATER	P.LAM.	PLASTIC LAMINATE	TYR	TYPICAL
COMP.	COMPRESSIBLE	HM	HOLLOW METAL FRAME	P.C.	PRECAST	U.N.O.	UNLESS NOTED OTHERWISE
COND.	CONDITION	HORIZ.	HORIZONTAL	P.L.	PROPERTY LINE	V.	VENT
CORR.	CORRIDOR	HT.	HEIGHT	P.P.	POWER POLE	V.F.	VERIFY IN FIELD
C.T.	CERAMIC TILE	I.D.	INSIDE DIAMETER	P.W.B.	PREFINISHED WALL BOARD	VENT.	VENTILATION, VENTILATED
CTG.	CLEAR TEMPERED GLASS	IP.S.	IRON PIPE SIZE	PL.	PLATE	VERT.	VERTICAL
CTSK.	COUNTERSINK	INSUL.	INSULATE(D), (ON)	PLUMB.	PLUMBING	W.P.	WATER PROOFING
D.F.	DRINKING FOUNTAIN	INT.	INTERIOR	PLYWD.	PLYWOOD	W.S.	WEATHERSTRIP
D.P.	DAMP PROOFING	JT.	JOINT	POL.	POLISHED	W.W.	WATER WELL
D.S.	DOWNSPOUT	L.P.	LIGHT POLE	PR.	PAIR	W.W.F.	WELDED WIRE FABRIC
DA.	DIAMETER	LAV.	LAVATORY	PR.	PAIR	W.	WITH
DIM.	DIMENSION	LT.	LIGHT	PRE-F.	PRE-FINISHED	WC	WATER CLOSET
DTL.	DETAIL	LT.WT.	LIGHTWEIGHT	PT.	POINT	WD	WOOD
DWG.	DRAWING			PTD.	PAINTED	WDW	WINDOW
E.J.	EXPANSION JOINT			R/RAD	RADIUS	WT	WEIGHT
EQ.	EQUAL			R.D.	ROOF DRAIN		
EA.	EACH			RE., REF.	REFER TO / REFERENCE / SEE		
				RECP.	RECEPTACLE		
				REINF.	REINFORCE(D), (ING)		

6 ABBREVIATIONS
N.T.S.

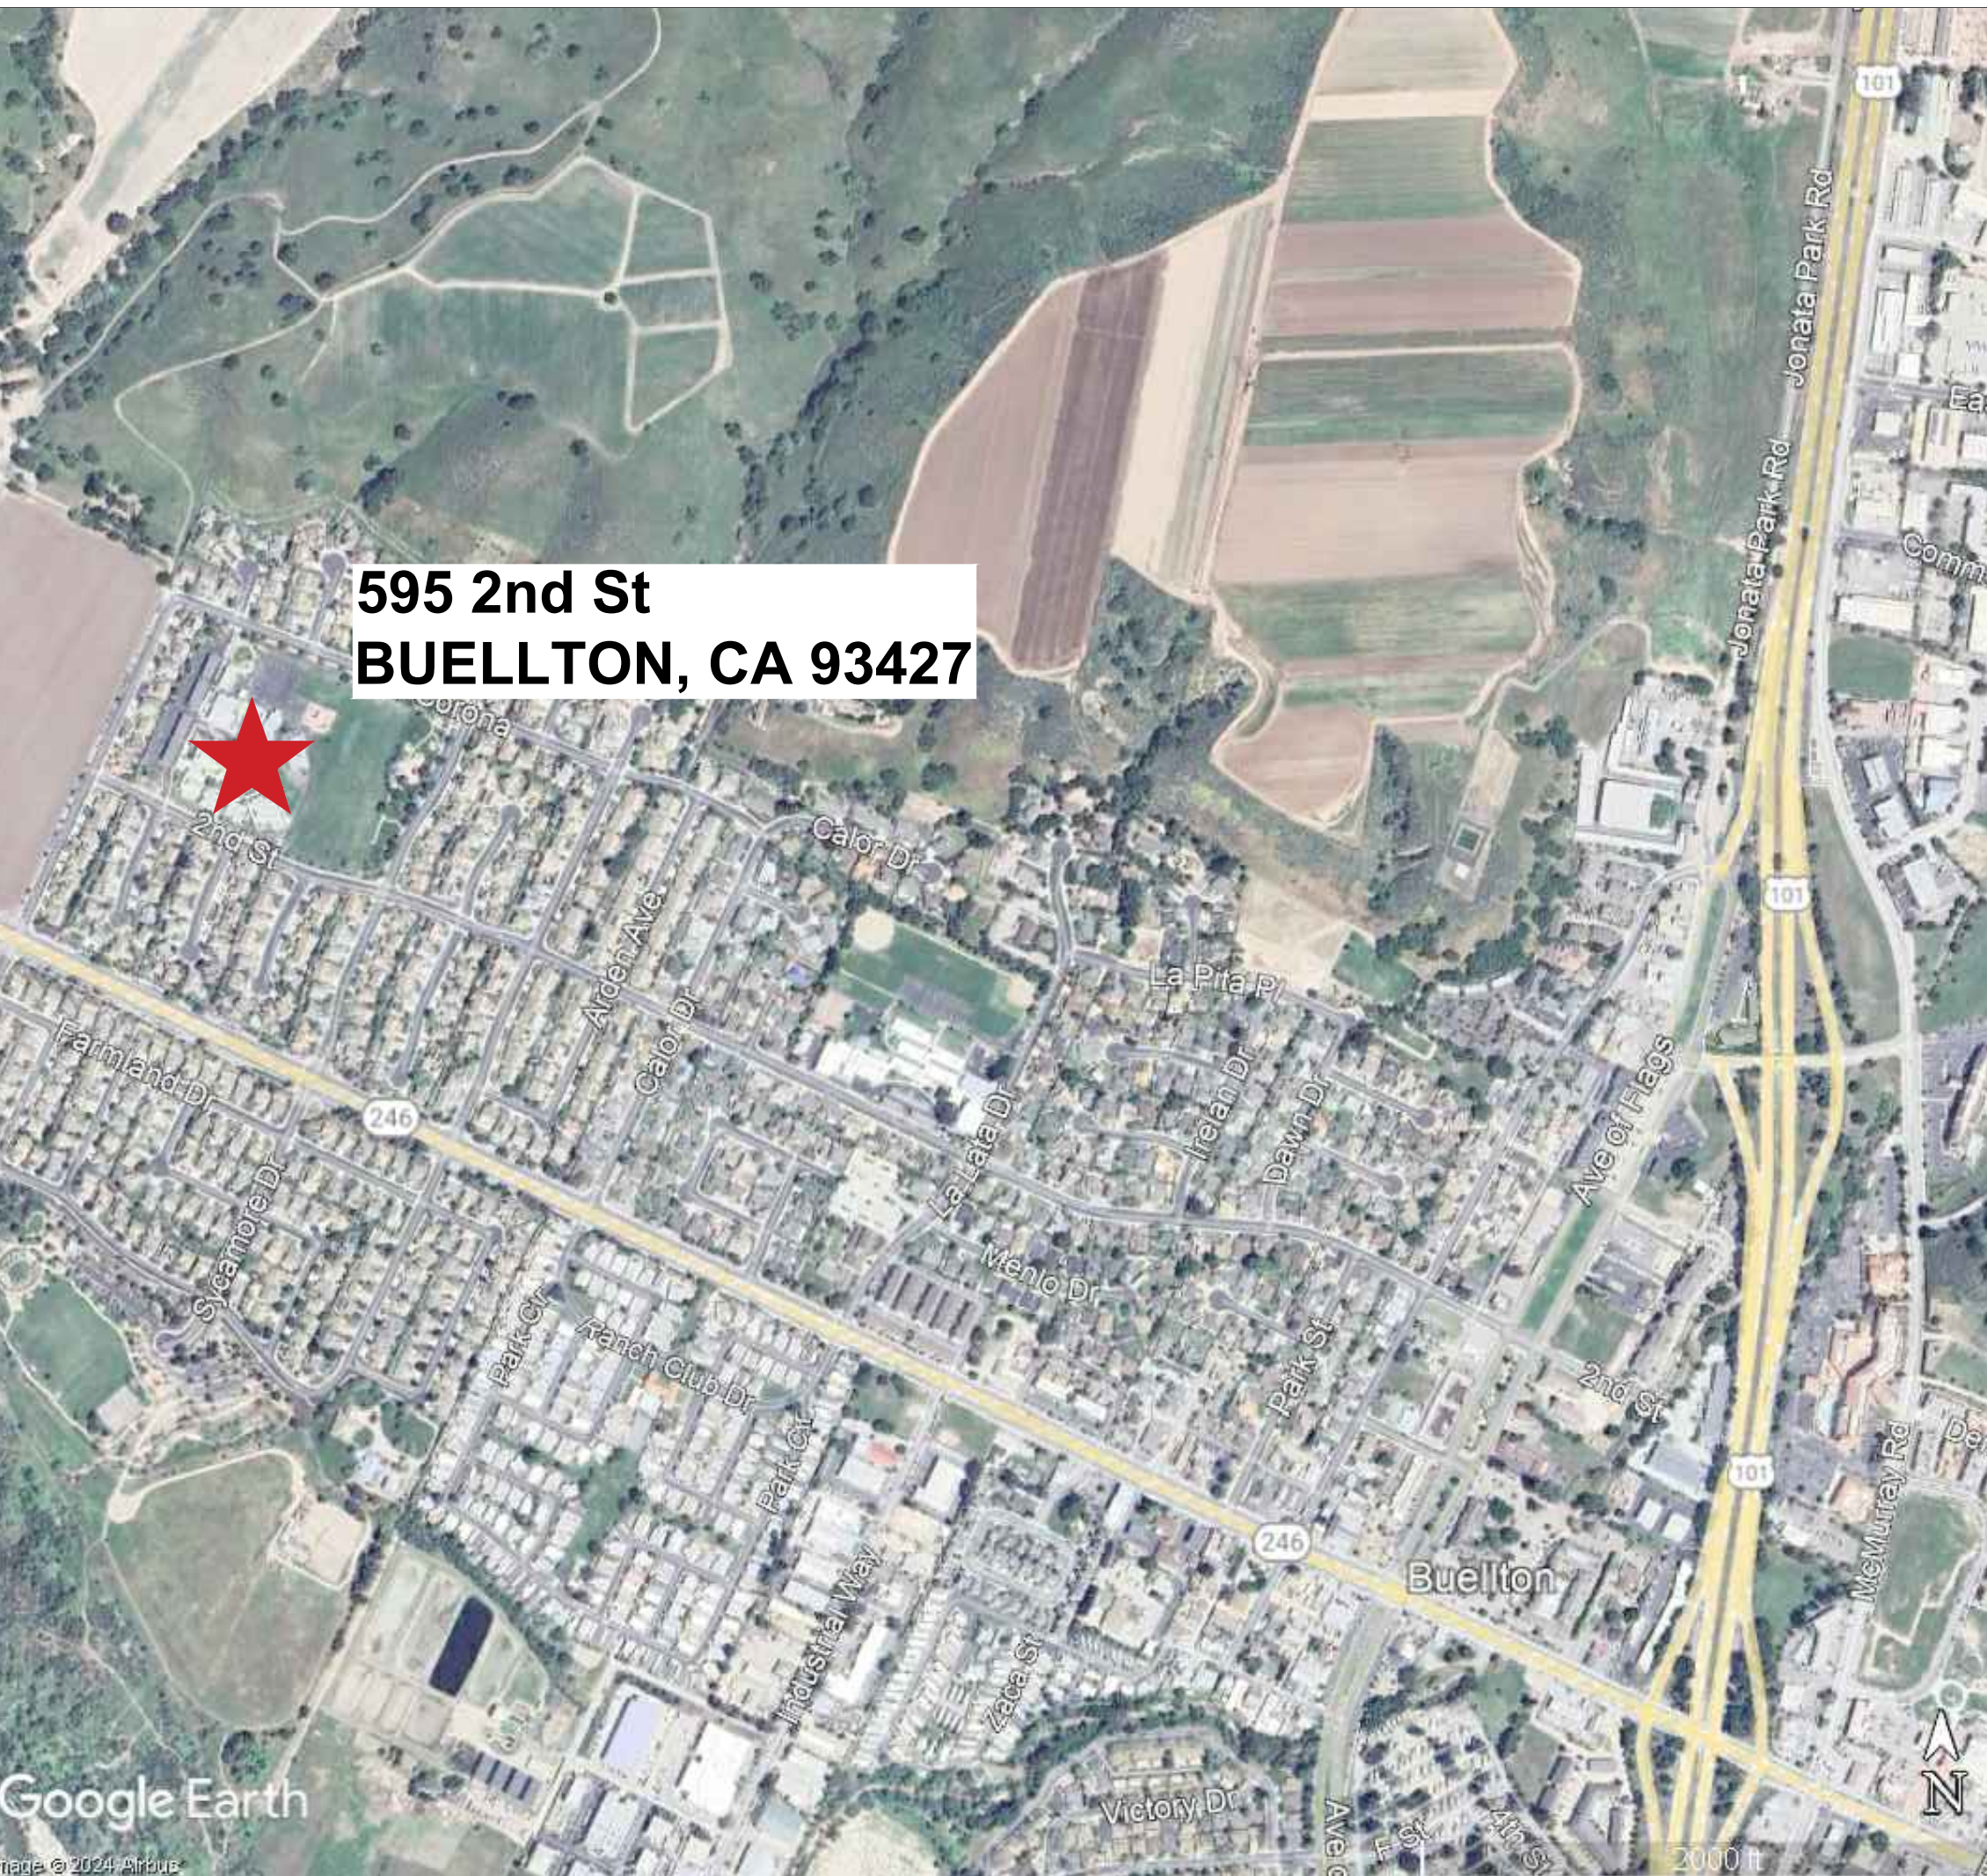


4 VICINITY MAP

BASE SCOPE:
SELECTIVE ROOFING MEMBRANE AT BUILDINGS A-MECHANICAL WELL, C, D, E, M, AND N TO BE REPAIRED AS INDICATED ON PLANS. CONTRACTOR TO REMOVE AND PROPERLY DISPOSE OF MEMBRANE IN ITS ENTIRETY DOWN TO THE EXISTING WOOD SUBSTRATE. SITE TO BE PROTECTED AT ALL TIMES AS BUILDING IS TO BE OCCUPIED WHILE CONSTRUCTION IS UNDERWAY. REMOVE ALL ROOFING MATERIAL FROM WALL/CURB LOCATIONS ALONG WITH ASSOCIATED FLASHINGS. REMOVE/REPLACE ALL WOOD DECKING THAT SHOW EVIDENCE OF DETERIORATED ROOF DECK MATERIAL. INFILL TO MATCH EXISTING ELEVATION. CLEAN AND PREP EXISTING SUBSTRATE TO RECEIVE NEW ROOFING SYSTEM. INSTALL MODIFIED BITUMEN TWO-PLY SYSTEM OVER MECHANICALLY FASTENED BASE SHEET WHERE INDICATED ON PLANS AND AT UP-SLOPED TRANSITION TO PARAPET WALL PER MANUFACTURER'S RECOMMENDATIONS. POWERWASH ROOFS A, C, D, E, M, AND N AND INSTALL NEW COATING PER MANUFACTURER RECOMMENDATIONS. INSTALL NEW SKYLIGHTS WHERE INDICATED ON PLANS. INSTALL NEW FLASHINGS AT MECHANICAL CURBS AND SKYLIGHTS.

ALTERNATE #1:
CLEANOUT AND REPAIR ALL GUTTERS AND DOWNSPOUTS AT BUILDINGS F, F1, I, I1, J, AND K. CLEAN AND PREP SURFACE FOR NEW SEALANT APPLICATION AT STANDING SEAM METAL JOINTS AND FASTENERS. INSTALL NEW SEALANT AT STANDING SEAM METAL JOINTS AND FASTENERS TO ENSURE A WATER TIGHT AND WEATHERPROOF METAL ROOFING SYSTEM.

26 SCOPE OF WORK

NOMENCLATURE "A"	
ROOF MEMBRANE	2-PLY MOD BIT
BASE SHEET	MECHANICALLY FASTENED

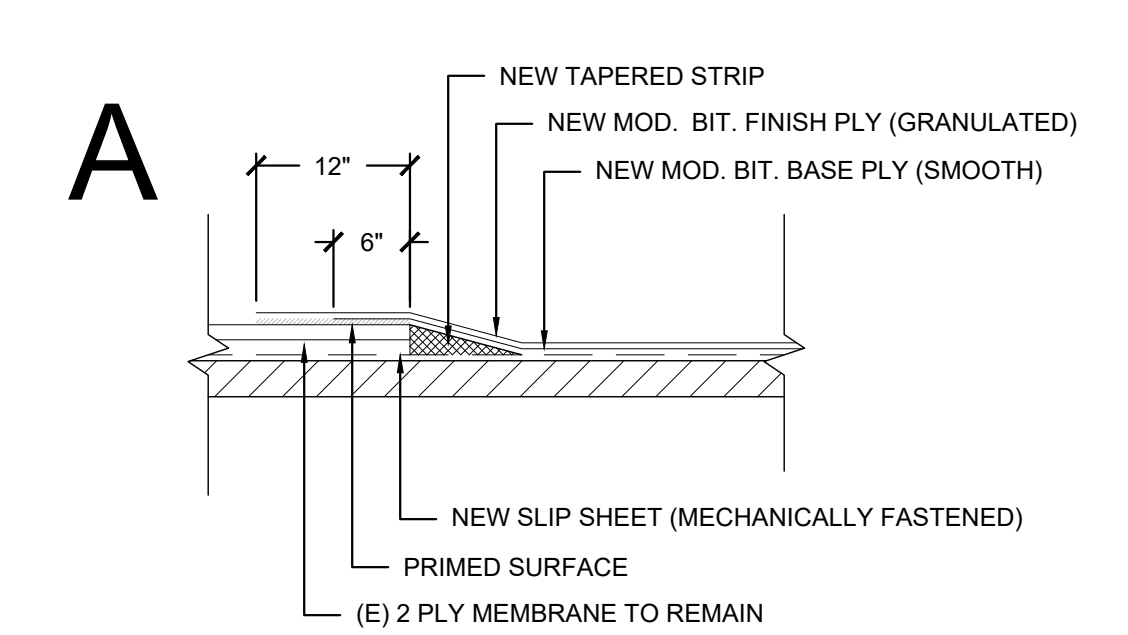

20 NEW NOMENCLATURE

AREA	APPROX. SQ. FT.	EXISTING NOMENCLATURE	NEW NOMENCLATURE	REMARKS
A	680	WD	A	-
C	2,390	WD	A	-
D	2,365	WD	A	-
E	8,490	WD	A	-
F	1,200	WD	-	1
F1	1,200	WD	-	1
I	4,800	WD	-	1
I1	520	WD	-	1
J	4,800	WD	-	1
K	4,800	WD	-	1
M	2,790	WD	A	-
N	2,850	WD	A	-
TOTAL	36885			

NOTE: SQUARE FOOTAGES SHOWN ARE FOR REFERENCE ONLY - FIELD VERIFY CONTRACTOR IS RESPONSIBLE FOR VERIFYING EXISTING CONDITIONS AND FOR DETERMINING NEW CONDITIONS WHERE TO ALL LOCAL AND FEDERAL CODES ALONG WITH INDUSTRY STANDARD GUIDELINES AND REMAIN IN A WATER TIGHT CONDITION.
SEE SPECIFICATION DIVISION 7 FOR OTHER ROOF RELATED COMPONENTS.

ABBREVIATIONS:
WD: WOOD DECK
BUR: BUILT-UP ROOF
MOD BIT: MODIFIED BITUMEN

REMARKS:

- GUTTER AND DOWNSPOUT REPAIR, SEALANT APPLICATION, AND NEW COATING OVER ROOF. SEE ALTERNATE #1 SCOPE OF WORK.

8 EXISTING NOMENCLATURE
N.T.S.

- PIPE PENETRATION (RE: 1/A2.0)
- ROOF HATCH (RE: /A2.0)
- CURB MOUNTED VENT (RE: 4/A2.0)
- ELECTRICAL LINE (RE: 3/A2.0)
- CURB MOUNTED VENT (RE: 4/A2.0)
- GAS LINE (RE: 3/A2.0)
- SKYLIGHT (RE: 8/A2.0)
- CONDENSATE LINE (RE: 3/A2.0)
- CURB MOUNTED A/C (RE: 4/A2.0)
- WALK PADS (RE: 7/A2.0)
- ROOF DRAIN
- SELECTIVE ROOFING REPAIRS
- MISC CURB (RE: 4/A2.0)
- DOWNSPOUT
- SCUPPER WITH CONDUCTOR HEAD (RE: 9/A2.0)
- SCUPPER (RE: 6/A2.0)
- CROSS OVER LADDER (RE: /A2.0)

2 LEGEND

- CONTRACTOR SHALL VISIT SITE TO ASCERTAIN EXACT EXISTING CONDITIONS AND COMPONENTS RELATED TO THE WORK DESCRIBED BY THESE DOCUMENTS. AFTER AWARD OF THE CONTRACT, CHANGE ORDER REQUEST FOR ADDITIONAL MONEY SHALL NOT BE APPROVED IF THE WORK COULD HAVE BEEN ANTICIPATED DURING THE SITE VISIT BY THE CONTRACTOR. ALL WORK SHALL BE COMPLETED IN ACCORDANCE WITH ACCEPTED MANUFACTURER'S PRINTED INSTRUCTIONS AND WARRANTY REQUIREMENTS.
- DIMENSIONS, DETAILS, EQUIPMENT SIZE AND LOCATION SHOWN IN THESE CONSTRUCTION DOCUMENTS ARE FOR CONVEYANCE OF DESIGN INTENT ONLY. EXACT SIZE, LOCATION, TYPE OF MATERIAL AND TYPE OF CONSTRUCTION OF EXISTING CONDITIONS ARE THE RESPONSIBILITY OF THE CONTRACTOR TO ASCERTAIN AND CONFIRM.
- REFER TO NOMENCLATURE FOR TYPE OF ROOF SYSTEM. ROOF AREAS ARE MARKED WITH DESIGNATED LETTER ON ROOF PLAN.
- NOTE THAT SOME OF THE DETAILS DRAWN ARE GENERIC IN NATURE AND ARE NOT NECESSARILY LOCATED AND KEYS TO THE ROOF PLANS.
- INDICATED ROOF HEIGHTS ARE GENERAL IN NATURE.
- ALL NEW CRICKETS AND TAPERED INSULATION SHALL BE INSTALLED WITH A FINISHED DOUBLE THE ROOF SLOPE. CRICKET THE UP-SLOPE SIDE OF ALL SQUARE CURBS AND PROJECTIONS OVER 20" IN WIDTH.
- REMOVE ALL ABANDONED EQUIPMENT IDENTIFIED ON SITE AND AS SHOWN ON OTHERWISE ON THESE DOCUMENTS.
- REPLACE ROTTED AND / OR OTHERWISE DETERIORATED ROOF DECK MATERIAL WITH LIKE MATERIAL AND THICKNESS.
- REPLACE ROTTED AND / OR OTHERWISE DETERIORATED WOOD NAILER MATERIAL WITH LIKE MATERIAL AND THICKNESS.
- PATCH EXISTING ROOF DECK FOR HOLES LESS THAN 10" WIDE BY ANCHORING 22 GA. STAINLESS STEEL SHEET METAL TO BOTTOM OF EXISTING STEEL ROOF DECK TO MATCH EXISTING THICKNESS. PATCH EXISTING ROOF DECK FOR HOLES GREATER THAN 10" WIDE BY ANCHORING 22 GA. STAINLESS STEEL SHEET METAL TO BOTTOM OF EXISTING GYPSUM ROOF DECK SPANNING FROM JOIST TO JOIST.
- AS APPLICABLE, ALL HVAC AND / OR DX UNITS, ELECTRICAL TRANSFORMERS, ROOF TOP EQUIPMENT, ETC. THAT ARE ON SLEEPERS SHALL BE DISCONNECTED / REMOVED, RAISED, AND PLACED ON NEW CURBED PLATFORMS AS DETAILED AND REINSTALLED / RECONNECTED. ALL CURB MOUNTED HVAC UNITS, EQUIPMENT, ETC. SHALL HAVE A MINIMUM 6" CURB HEIGHT AND ARE TO BE RAISED AS REQUIRED.
- ALL DISCONNECTS AND RECONNECTS SHALL BE PERFORMED BY A LICENSED ELECTRICIAN.
- WORK TO ANY EXISTING UTILITY CONDUIT OR PIPE SHALL BE PERFORMED BY SPECIFIC LICENSED SUBCONTRACTORS SPECIALIZING IN HVAC, PLUMBING AND ELECTRICAL WORK. PERMITS AND INSPECTIONS ARE REQUIRED. REROUTE AND / OR MODIFY UTILITY CONDUIT OR PIPE AS REQUIRED TO BE INSTALLED AS DETAILED.
- UNLESS INDICATED OTHERWISE ON THE CONSTRUCTION DOCUMENTS, REPLACE AND RAISE (AS REQUIRED) ALL EXISTING EXPANSION JOINTS / AREA DIVIDERS / CURB MOUNTED EQUIPMENT / EXISTING ROOF HATCH / SKYLIGHTS A MIN. 10" ABOVE ROOF DECK.
- ALL SOIL STACK FLASHING SHALL BE A MIN. 10" ABOVE FINISHED ROOF SURFACE. COUPLE PVC PIPE ABOVE DECK AND COUPLE CAST IRON PIPE BELOW DECK.
- ALL PIPING / CONDUIT / ETC. SHALL BE A MIN. 10" ABOVE ROOF SURFACE. PROVIDE PORTABLE PIPE HANGERS WITH PROTECTION PADS.
- PROVIDE SHEET METAL HOODED (WITH METAL FACE CLOSURE) CAPS, WOOD WOOD CURB, BOX COVER AT ALL GAS AND WATER PIPE ROOF PENETRATIONS AS DETAILED. PROVIDE POSITIVE SLOPE AWAY FROM FACE COVER.
- PROVIDE WALKWAY PROTECTION PADS AS SPECIFIED AROUND ALL ROOF HATCHES, HVAC ROOF TOP UNITS, DOORS THAT OPEN ON ROOF AND AT TOP AND BOTTOM OF ALL ROOF TOP ACCESS LOCATIONS.
- INSTALL NEW SPLASH PAN AT ALL LOCATIONS WHERE ROOF DRAINAGE DISCHARGES ONTO ROOF AREA. INSTALL NEW SPLASH BLOCKS WHERE ROOF DRAINAGE DISCHARGES ON GROUND.
- ISOLATE ALL HEAT PIPES / FLUES AS DETAILED AND RECOMMENDED AND OUTLINED IN THE NRCA MANUAL FOR HOT STACK FLASHING.
- ALL OUTSIDE AIR INTAKES SHALL BE COVERED TO ELIMINATE ODORS AND FUMES FROM ENTERING INTO THE BUILDING DURING CONSTRUCTION WORK.
- EXAMINE AND CLEAN EXISTING DRAIN LINES OF DEBRIS AND BLOCKAGE, FLUSH WITH WATER TO ENSURE THAT DRAINS FLOW FREELY. REPAIR EXISTING DRAINS AS REQUIRED.
- OWNER WILL VERIFY PROPER OPERATION OF ALL ROOF TOP EQUIPMENT BEFORE AND AFTER THE PROJECT. CONTRACTOR SHALL BE RESPONSIBLE FOR IDENTIFYING ALL INOPERABLE EQUIPMENT PRIOR TO RELEASE OF PROJECT.
- REPLACE RUSTED AND / OR DETERIORATED EXISTING METAL VENT FLASHING AND FLUES.
- PRIOR TO COMMENCEMENT OF WORK, COORDINATE WALK OF ENTIRE ROOF WITH ROOFING MANUFACTURER'S TECHNICAL REPRESENTATIVE TO IDENTIFY AND LOCATE ALL AREAS OF HIGH SLOPE OR OTHER CONDITIONS WHICH MIGHT REQUIRE SPECIAL PROCEDURES FOR SYSTEM ATTACHMENT.
- PAINT ALL EXPOSED GAS PIPE TO REMAIN.
- EXISTING OVERFLOW DRAIN LINE PIPES ARE TO BE REPLACED WITH OVERFLOW ROOF DRAIN ASSEMBLIES PER PLUMBING SPECIFICATIONS.

13 GENERAL NOTES

APPLICABLE CODES AND STANDARDS:
2022 CALIFORNIA ADMINISTRATIVE CODE (CAC)
2022 CALIFORNIA BUILDING CODE (CBC)
2022 CALIFORNIA ELECTRICAL CODE (CEC)
2022 CALIFORNIA MECHANICAL CODE (CMC)
2022 CALIFORNIA PLUMBING CODE (CPC)
2022 CALIFORNIA ENERGY CODE (CEC)
2022 CALIFORNIA FIRE CODE (CFC)
2022 CALIFORNIA EXISTING BUILDING CODE (CEBC)
2022 CALIFORNIA GREEN BUILDING STANDARDS CODE (CALGREEN)
2022 CALIFORNIA REFERENCED STANDARDS CODE

DSA REQUIREMENTS:
DSA REVIEW: EXEMPTED - ROOF REPAIR SCOPE - DSA IR A-22

APPLICABLE LOADS (CBC 1603A.1 & ASCE 7-16)
BUILDING OCCUPANCY CATEGORY: E (EDUCATION)
NON-OCCUPABLE ROOF LIVE LOAD:
SUPERIMPOSED DEAD LOAD (ASCE 7-16): 20 PSF
3 PSF < 5 PSF

1/2" DENS DECK	2.1 PSF
1/2" RIGID INSULATION	0.2 PSF
2-PLY MEMBRANE	1.4 PSF
TOTAL	3.7 PSF

RAIN 100-YR: 2 IN/HR
SNOW: P_s = 0
ICE: 0 IN
WIND: EXPOSURE CATEGORY B (CBC 2022)
V₁₋₁₀ = 102 MPH (CBC Table 1609.3.1 & 1609.3.2)
V₅₀ = 85 MPH

7 CODES AND STANDARDS

GENERAL SHEETS
G0.0 GENERAL INFORMATION

BUILDING ENVELOPE
A1.0 ROOF PLAN
A1.1 ROOF PLAN CONT.
A1.2 ROOF PLAN CONT.
A2.0 ROOFING DETAILS

95% CD

G0.0

1 INDEX





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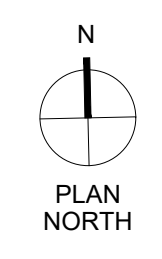
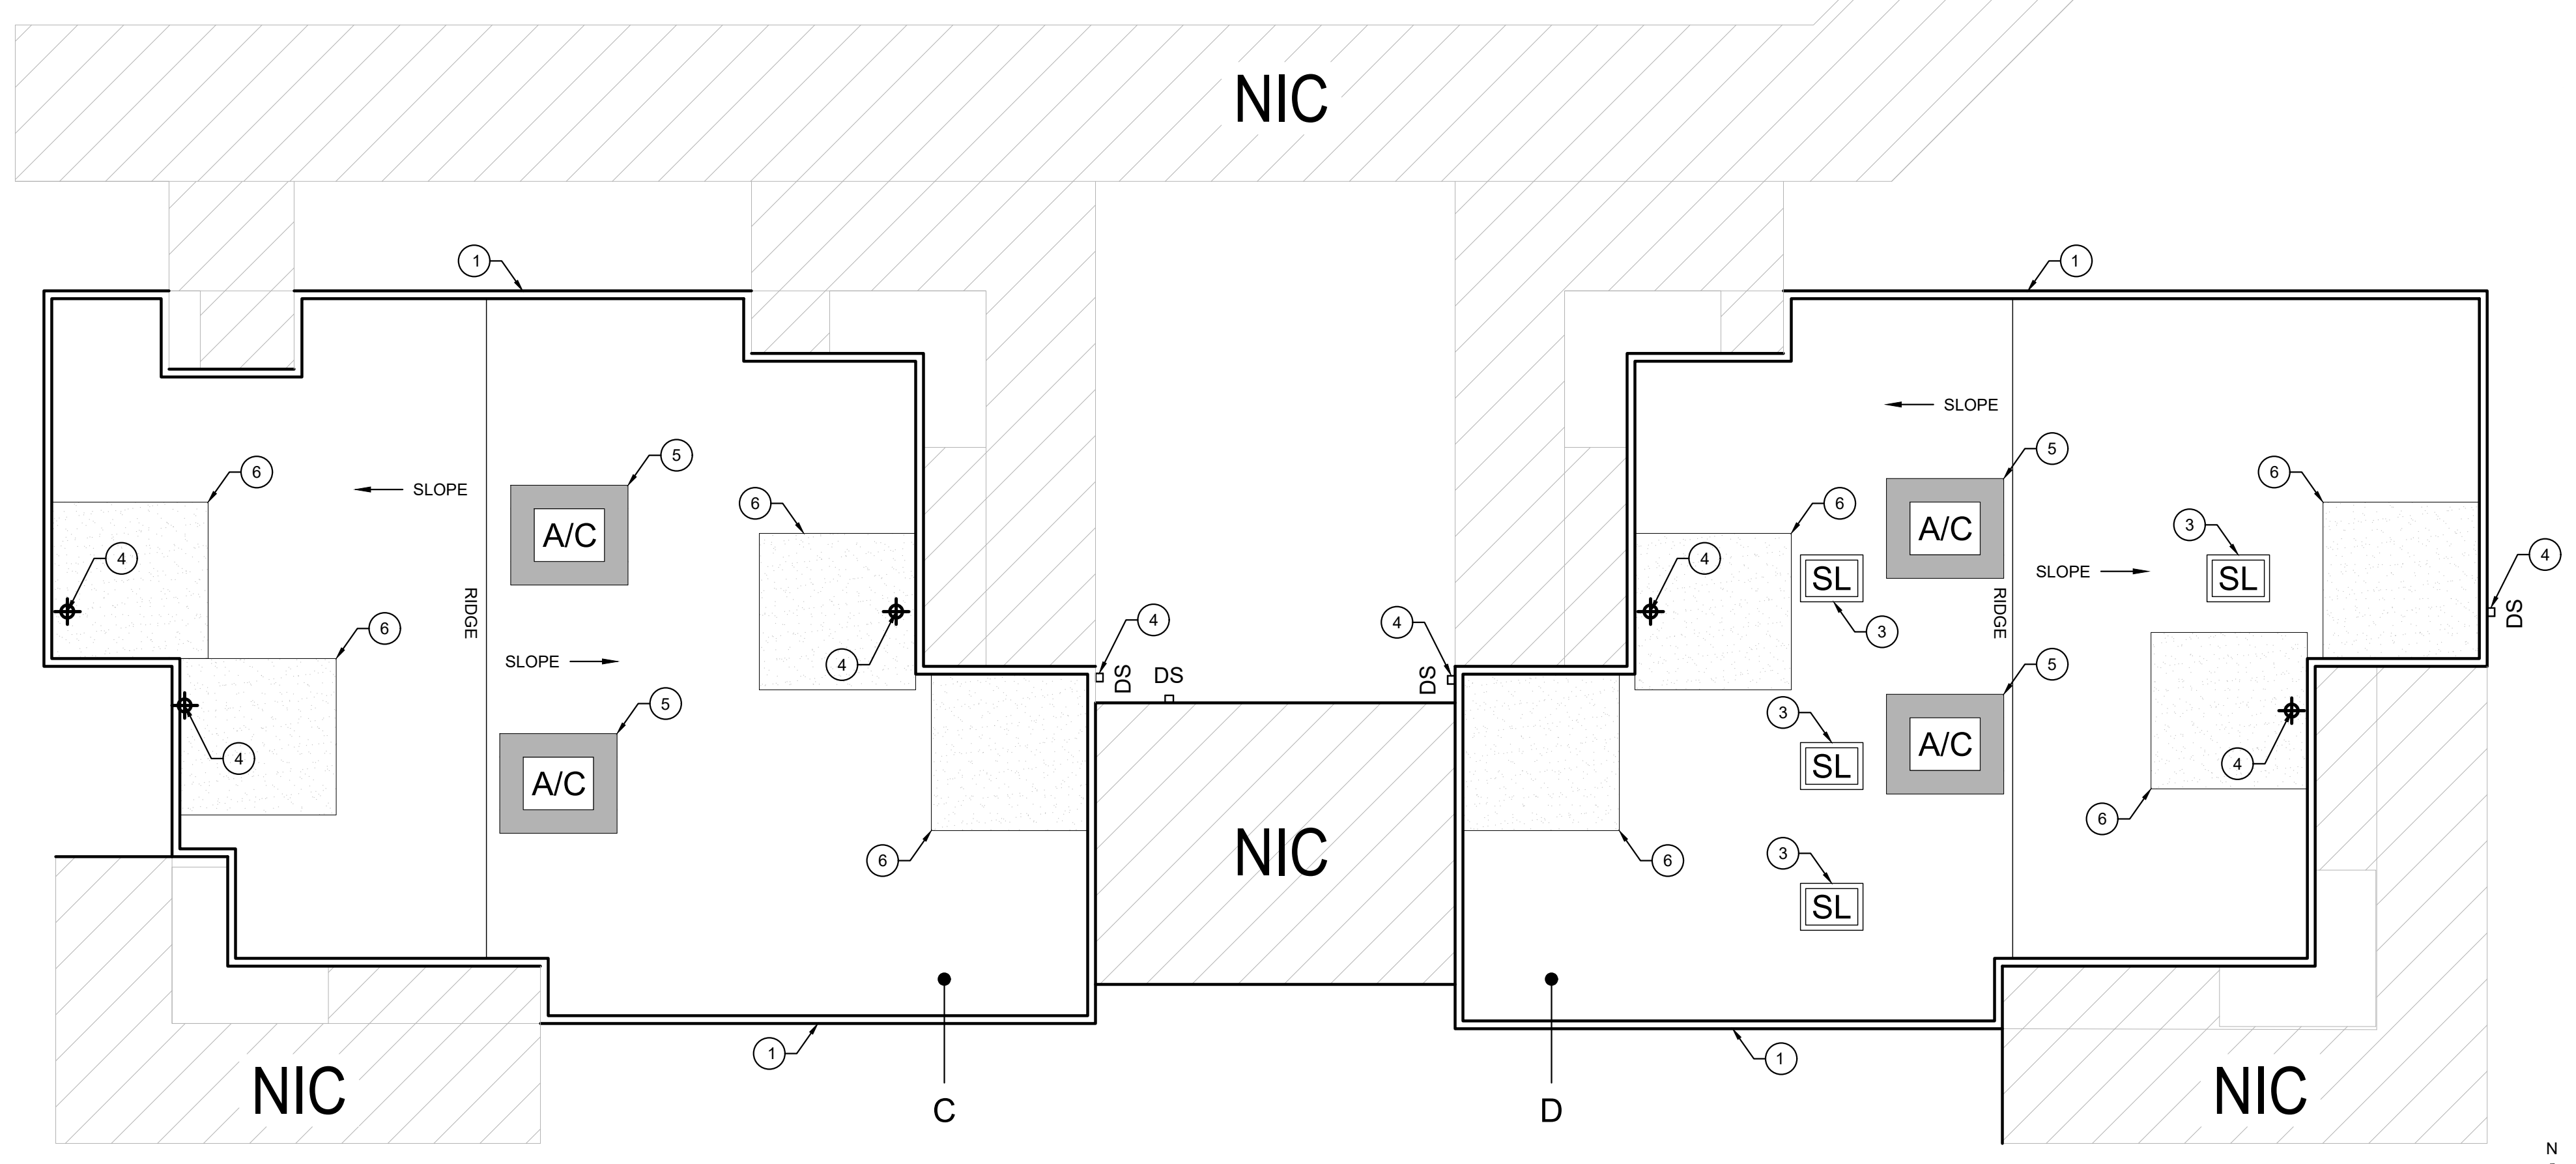


PROJECT NUMBER	230610.3	
DATE	03/07/2024	
DRAWN BY	AV	
REVISIONS		
#	DESCRIPTION	DATE

GENERAL INFORMATION



17 ROOF PLAN - AREA "E"
1/8"=1'-0"

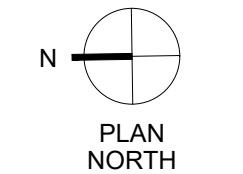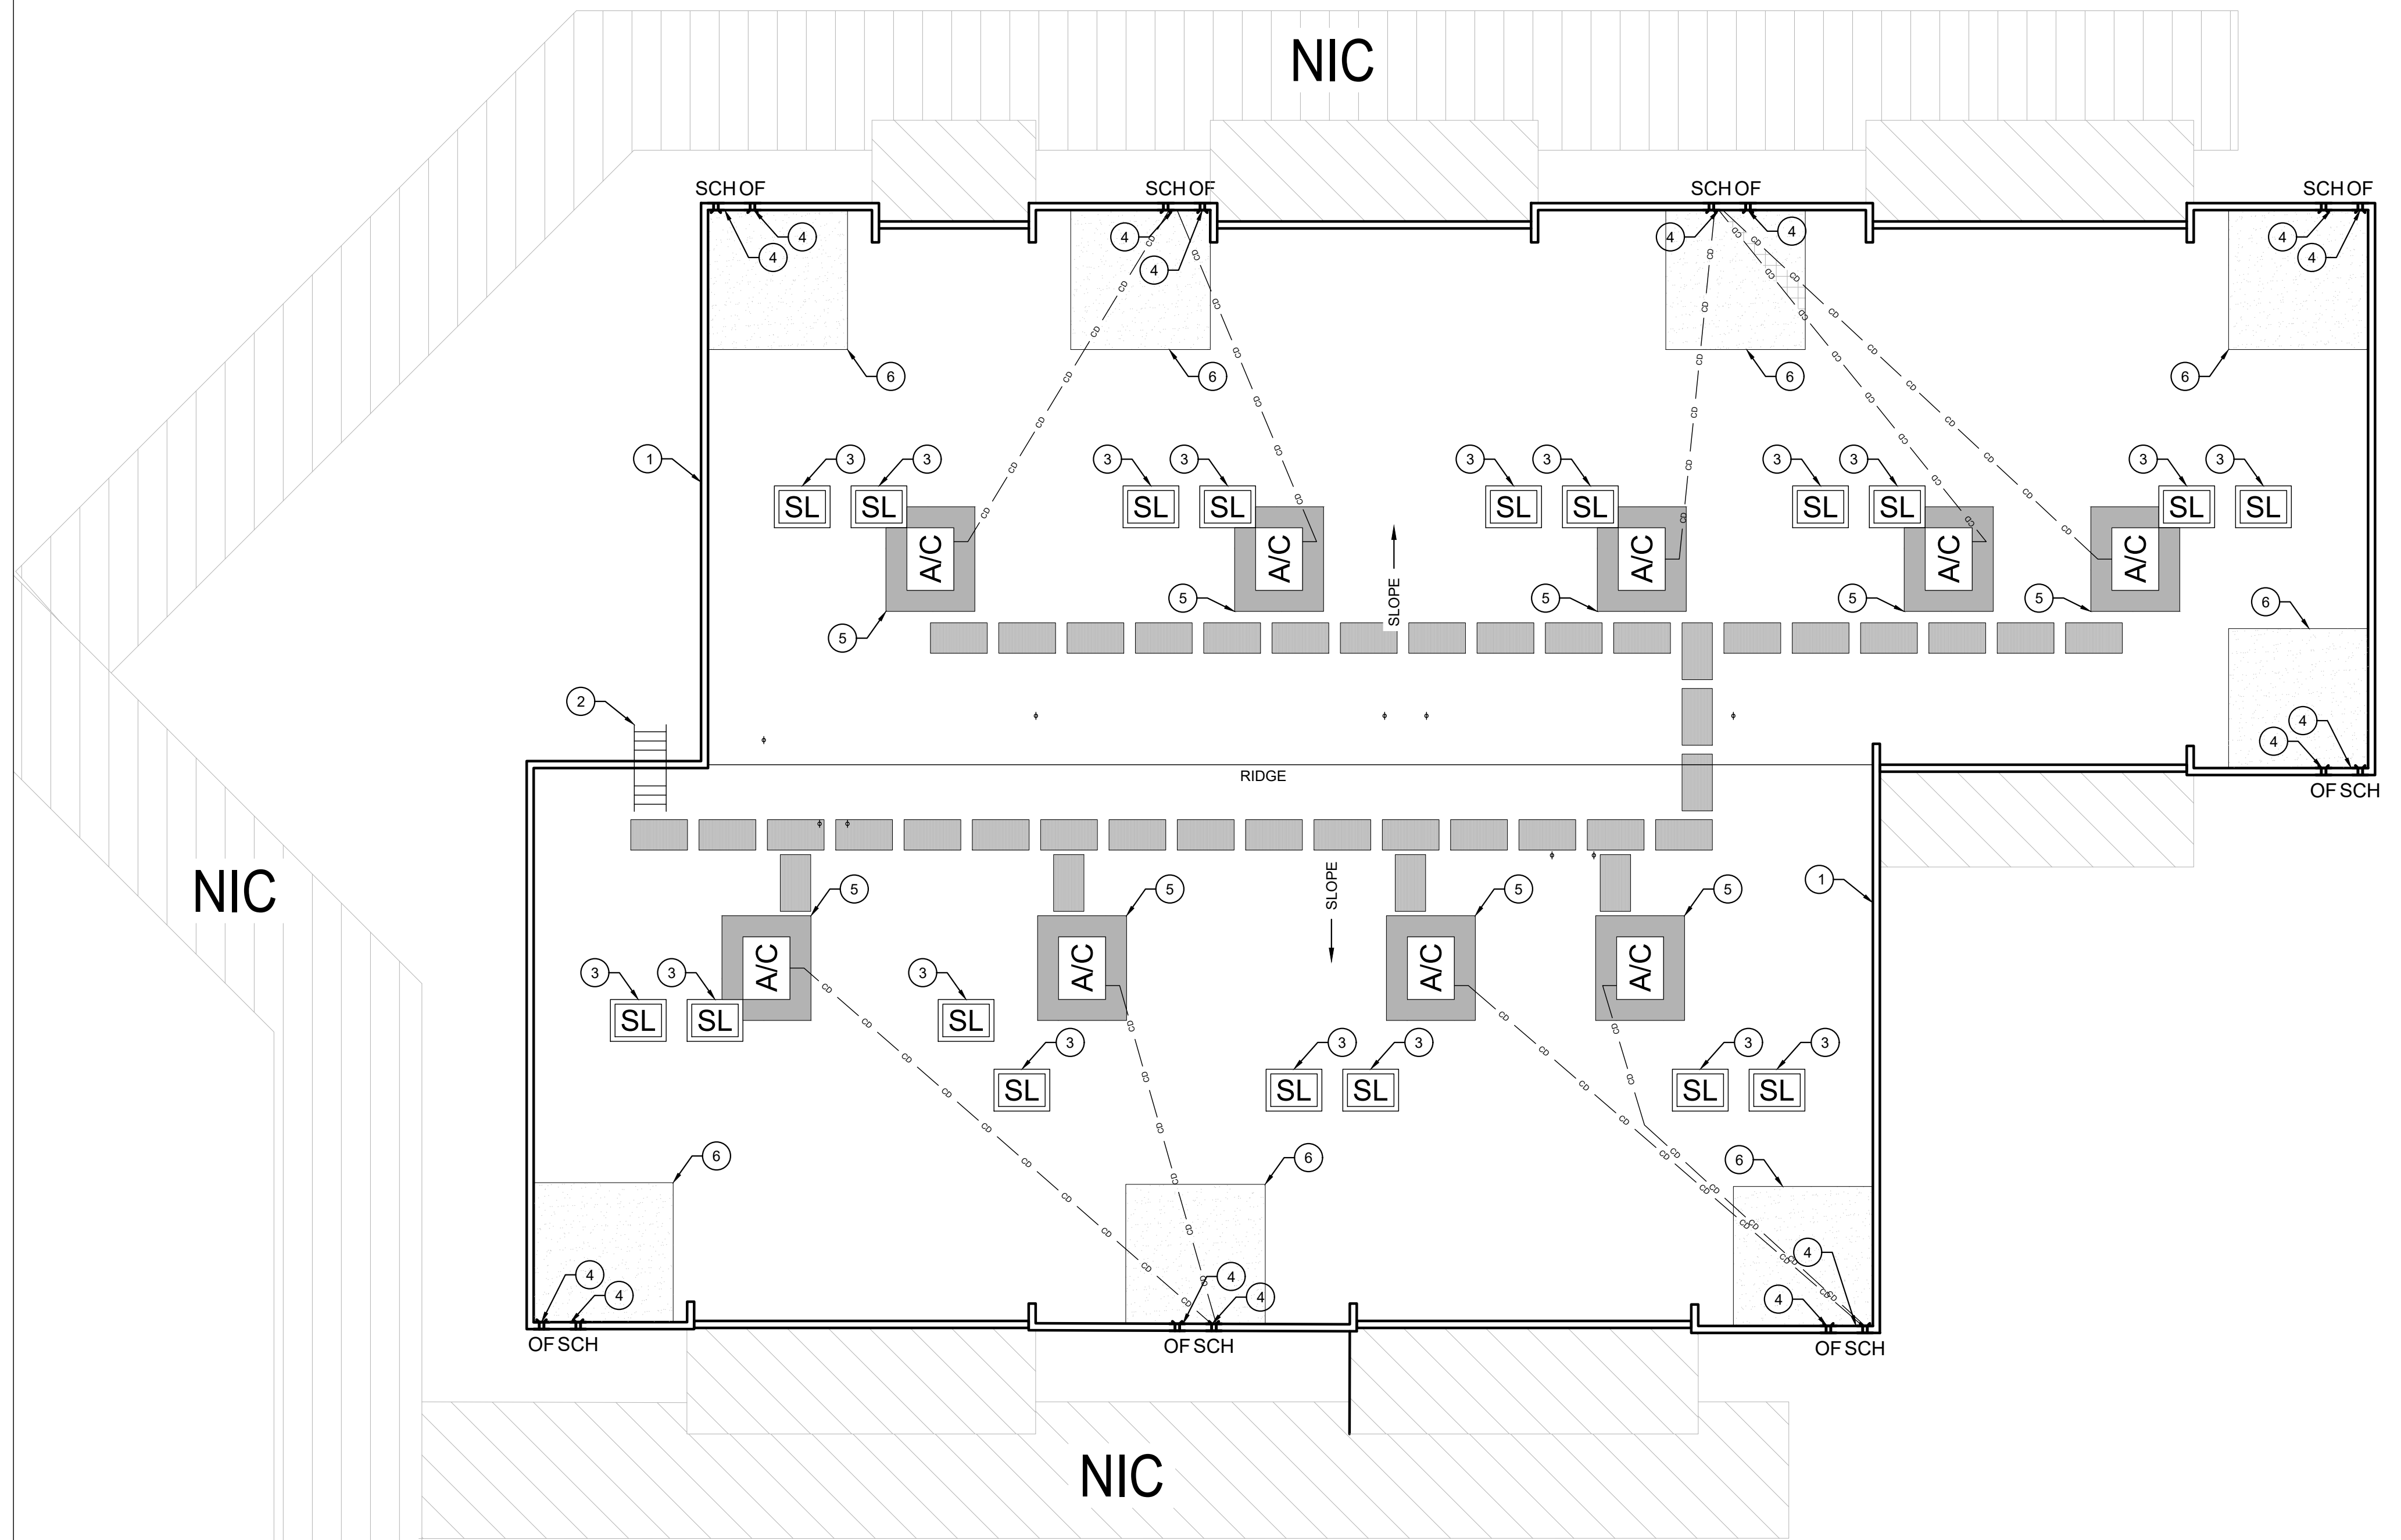

5 ROOF PLAN - AREAS: "C" & "D"
1/8"=1'-0"

- 1 PERIMETER COPING METAL TO BE PROTECTED AND REMAIN IN PLACE DURING INSTALLATION OF NEW ROOF COATING. REFERENCE SPECIFICATION SECTION 07 62 00.
- 2 LADDER AND/OR ROOF HATCH TO REMAIN.
- 3 SKYLIGHTS TO BE REPLACED ALONG WITH ASSOCIATED METAL FLASHINGS.
- 4 THROUGH-WALL SCUPPERS, SCUPPER OVERFLOWS, ROOF DRAINS, ROOF OVERFLOW DRAINS ARE TO BE REPLACED ALONG WITH ASSOCIATED METAL FLASHINGS. EXISTING DOWNSPOUTS AND COLLECTOR HEADS ARE TO BE PROTECTED AND REMAIN.
- 5 ACCESSORY/UNIT CURB METAL TO BE PROTECTED AND/OR RAISED TO INSTALL NEW ROOF COATING AS NECESSARY. WHERE INDICATED ON PLANS, INSTALL NEW WALKPADS AROUND UNITS PER SPECIFICATION SECTION 07 52 00 AND 07 56 00.
- 6 SELECTIVE ROOF REPAIR PER SCOPE OF WORK. APPROXIMATELY 100 SQUARE FOOT SECTIONS.
- 7 ROOF AREA TO RECEIVE SEALANT MAINTENANCE, GUTTER CLEAN-OUT, DOWNSPOUT REPAIR, AND NEW ROOF COATING PER SPECIFICATION SECTION 07 56 00.

2 KEYNOTES

- ☐ PIPE PENETRATION (RE: 1/A2.0) ☐ ROOF HATCH (RE: /A2.0)
- ☒ CURB MOUNTED VENT (RE: 4/A2.0) -E- ELECTRICAL LINE (RE: 3/A2.0)
- ☒ CURB MOUNTED VENT (RE: 4/A2.0) -G- GAS LINE (RE: 3/A2.0)
- ☒ SKYLIGHT (RE: 8/A2.0) -CD- CONDENSATE LINE (RE: 3/A2.0)
- A/C CURB MOUNTED A/C (RE: 4/A2.0) ■ WALK PADS (RE: 7/A2.0)
- ⊕ ROOF DRAIN □ SELECTIVE ROOFING REPAIRS
- ☒ MISC CURB (RE: 4/A2.0)
- DS DOWNSPOUT
- ⊕ SCUPPER WITH CONDUCTOR HEAD (RE: 9/A2.0)
- ⊕ SCUPPER (RE: 6/A2.0)
- ☐ CROSS OVER LADDER (RE: /A2.0)

1 LEGEND



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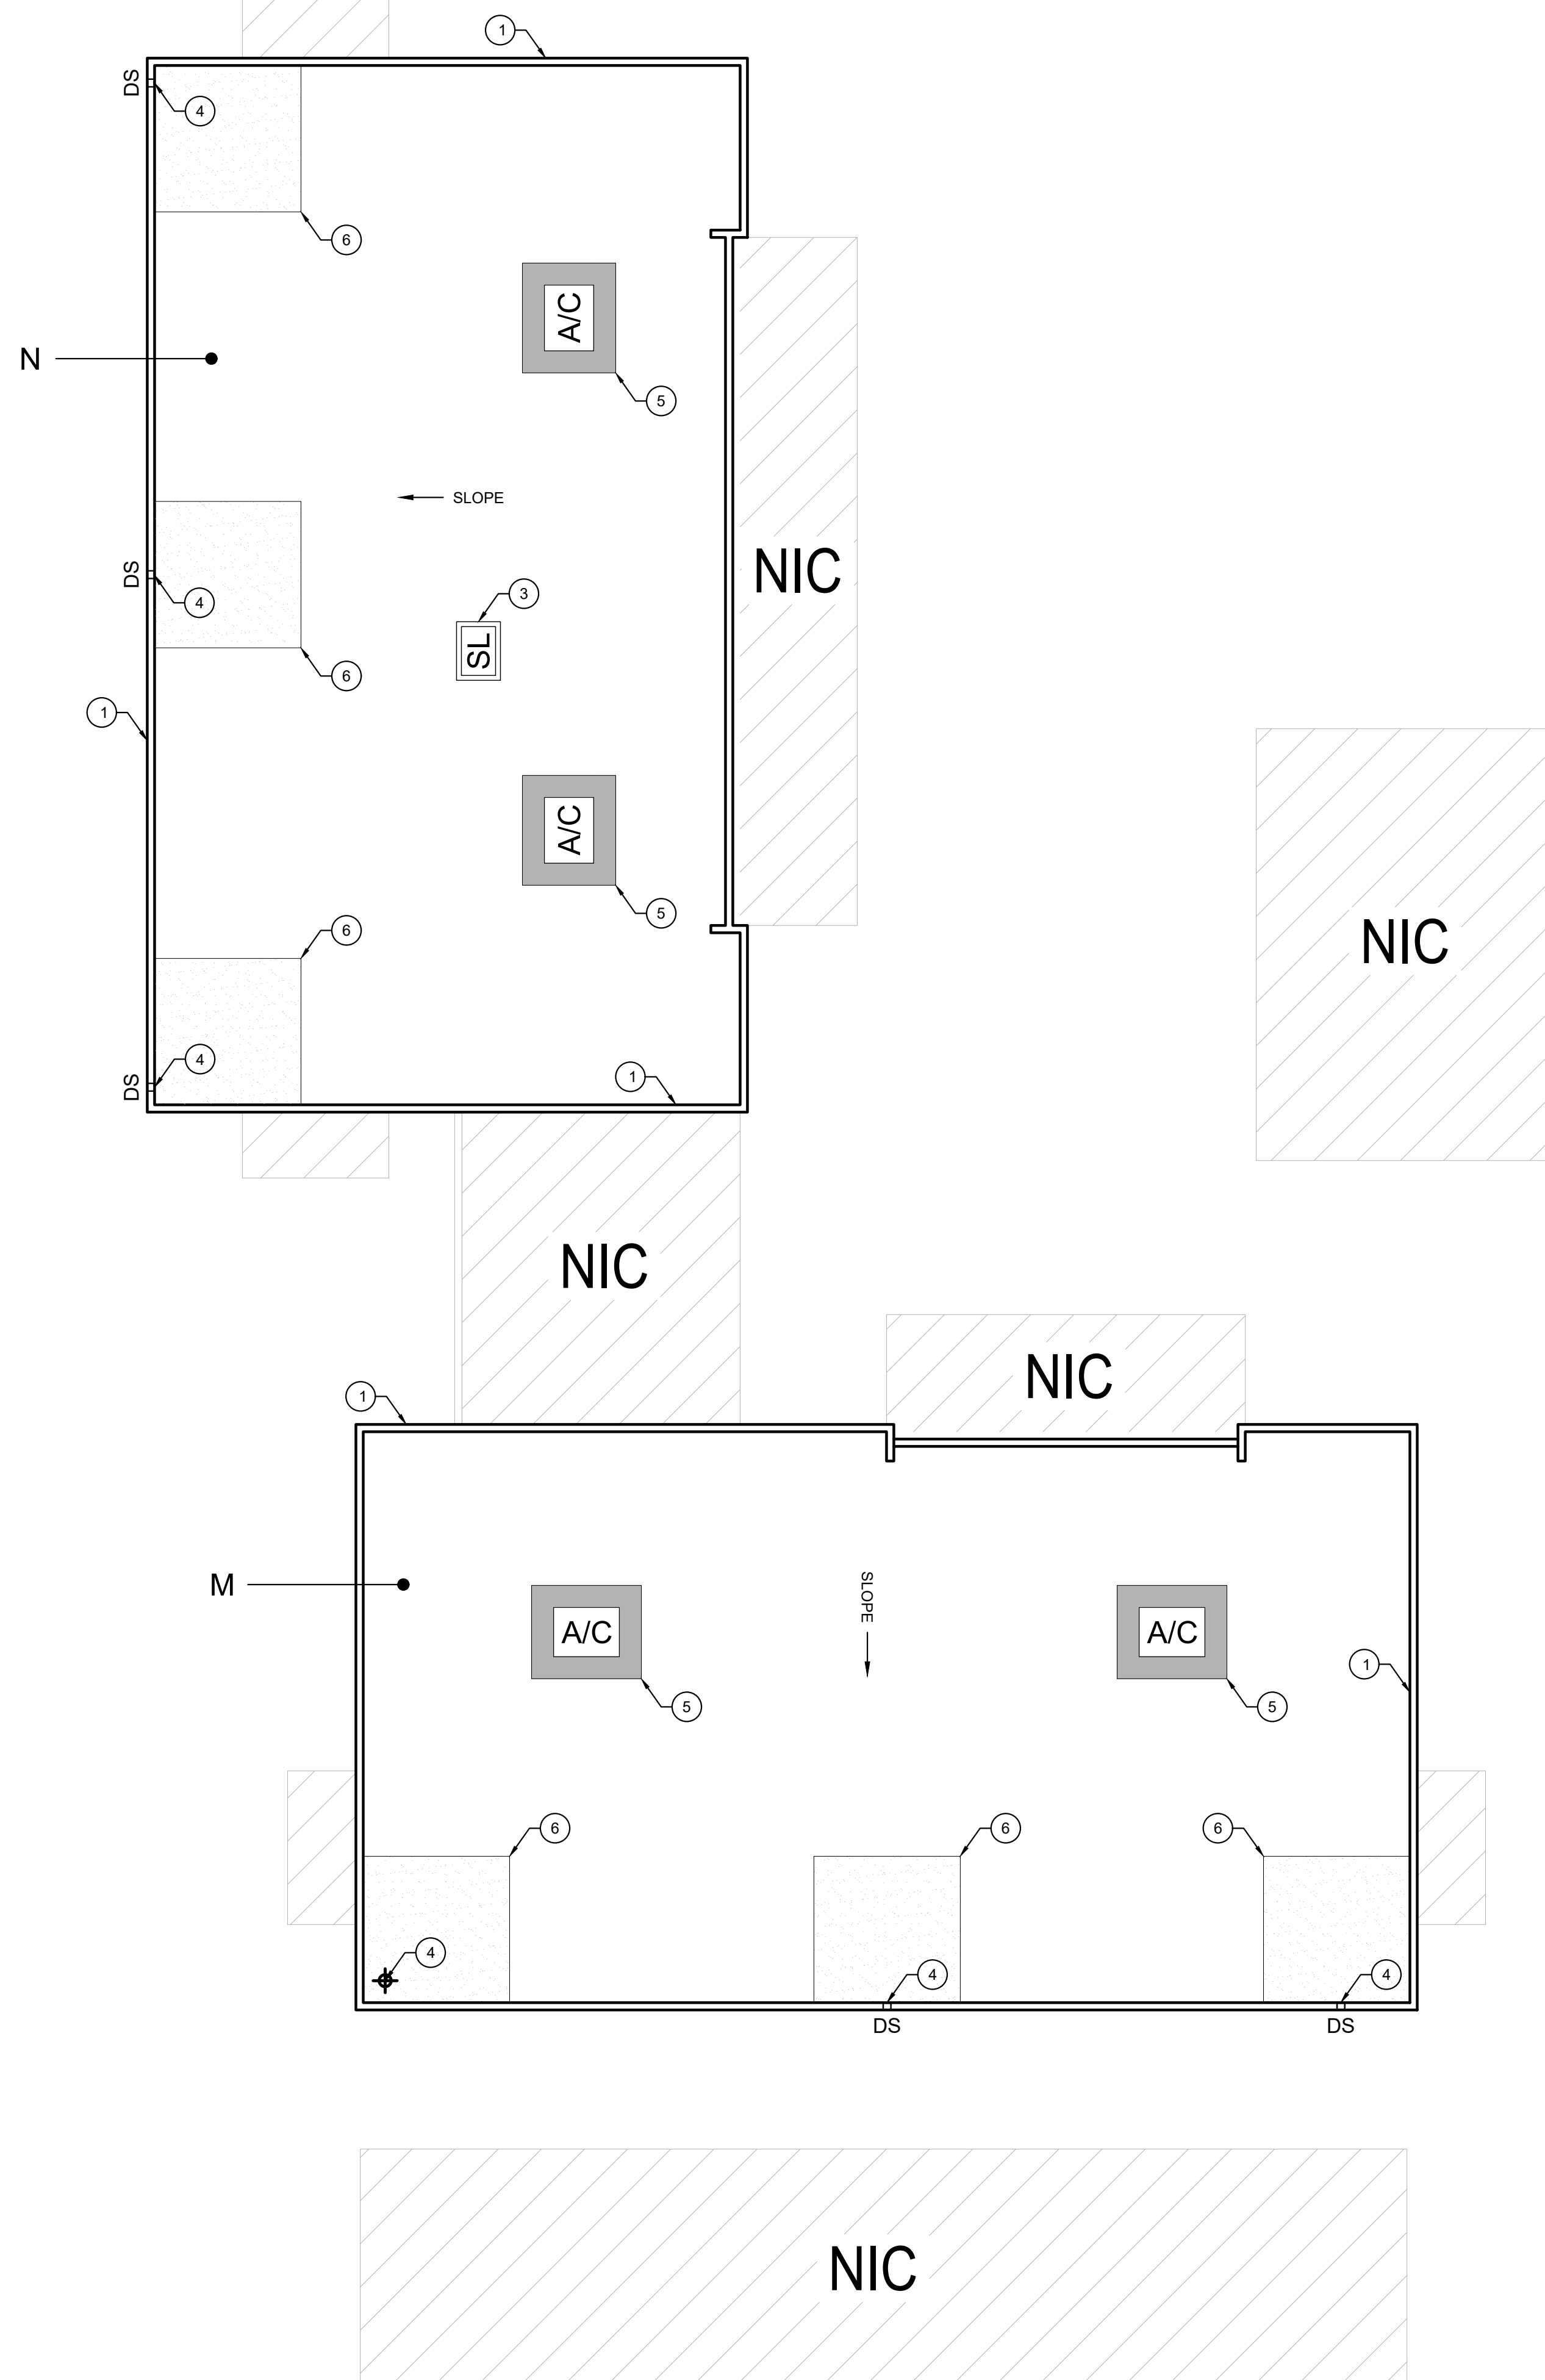
ROOF PLAN

- ① PERIMETER COPING METAL TO BE PROTECTED AND REMAIN IN PLACE DURING INSTALLATION OF NEW ROOF COATING. REFERENCE SPECIFICATION SECTION 07 82 00.
- ② LADDER AND/OR ROOF HATCH TO REMAIN.
- ③ SKYLIGHTS TO BE REPLACED ALONG WITH ASSOCIATED METAL FLASHINGS.
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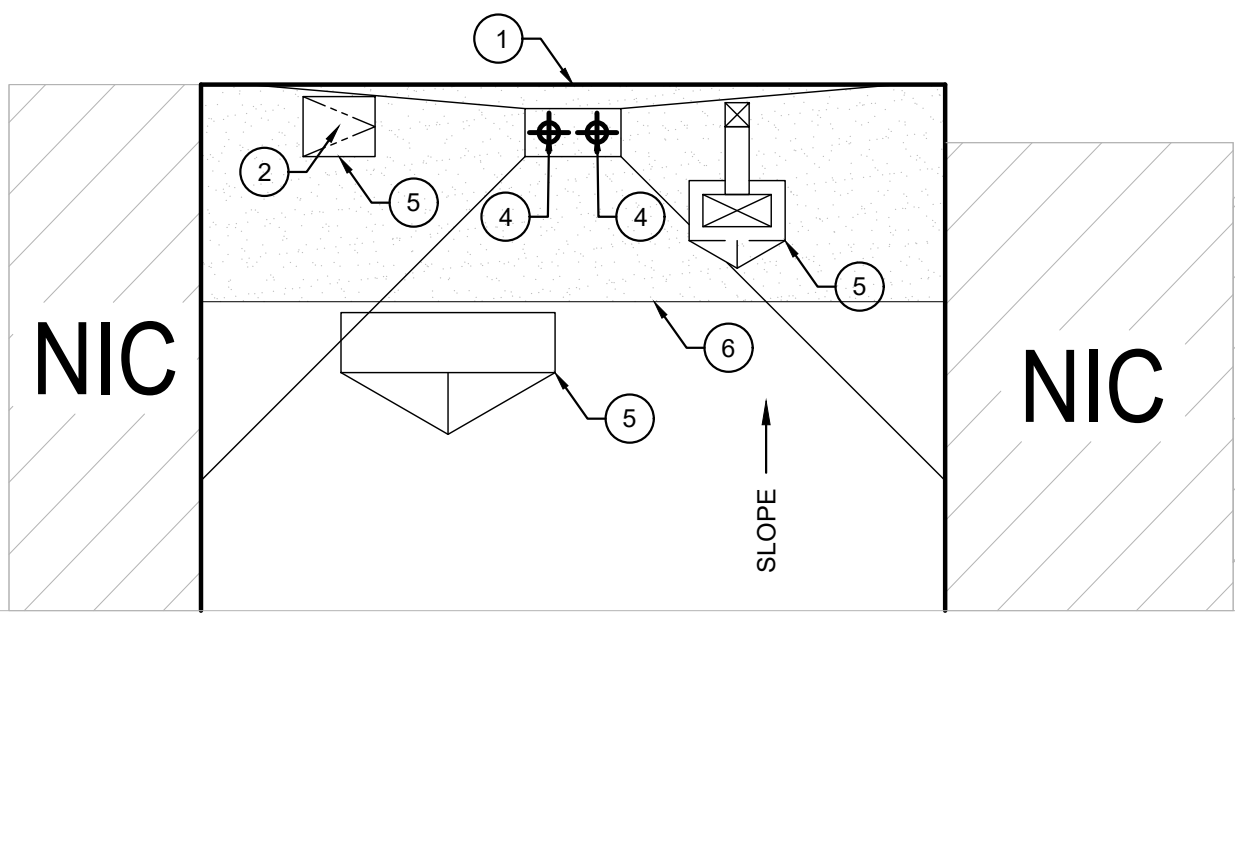
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- MC MISC CURB (RE: 4/A2.0)
- DS DOWNSPOUT
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- SC SCUPPER (RE: 6/A2.0)
- CLL CROSS OVER LADDER (RE: /A2.0)
- RF ROOF HATCH (RE: /A2.0)
- EL ELECTRICAL LINE (RE: 3/A2.0)
- GL GAS LINE (RE: 3/A2.0)
- CD CONDENSATE LINE (RE: 3/A2.0)
- WP WALK PADS (RE: 7/A2.0)
- SR SELECTIVE ROOFING REPAIRS

2 KEYNOTES

1 LEGEND



3 ROOF PLAN - AREAS: "M" & "N"
1/8"=1'-0"



6 ROOF PLAN - AREAS: "A"
1/8"=1'-0"



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DRAWN BY AV

REVISIONS

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A1.1

ROOF PLAN CONT.

